
LEGEND:

STANDARD NUMBER	@	•	-	BOLLARD	101	_	GAS METER
CONSTRUCTION NOTE	①	0	-	SANITARY SEWER MANHOLE	_		MAILBOX
WIRE RUN	\triangle	•	-	STORM SEWER MANHOLE		_	SIGN
SIGNAL CONTROLLER			_	CATCH BASIN	4	_	
SERVICE CABINET	X	∞ ₀	_	CLEANOUT			BOUNDARY LINE
MAST ARM SIGNAL WITH LUMINAIRE) 	RD _o	_	ROOF DRAIN		-	LOT LINE
MAST ARM SIGN —	3	-					R.O.W. CENTERLINE
	(S -1)	æ	-	WATER METER			EXISTING R.O.W. LINE
VEHICLE SIGNAL HEAD -	<u>→</u>	0	-	WATER VALVE		-	PROPOSED R.O.W. LINE
	↓ ►	Ճ	-	SPRINKLER VALVE			EXISTING EASEMENT LINE
SIGNAL HEAD WITH — TURN INDICATION	▼	රු	-	HOSE BIB	т	_	UNDERGROUND TELCO LINE
PEDESTRIAN SIGNAL HEAD		W	-	WATER VAULT		_	UNDERGROUND TELCO LINE (PER MAPS)
EMERGENCY VEHICLE PREEMPTION DETECTOR		ф-	_	FIRE HYDRANT			UNDERGROUND POWER
VIDEO DETECTION -	——□□< V 0	×	_	FIRE CONNECTION	——P(UG)——	_	
TYPE 1 J-BOX		^ <u></u> 50	_	TELCO RISER	— с —	_	GAS LINE
TYPE 2 J-BOX					—— ОНР ——		OVERHEAD POWER LINE
TYPE 7 J-BOX	0	•	-	UTILITY POLE	w	-	WATER LINE
PULL BOX	□	→	-	GUY WIRE/POLE	(W)	-	WATER LINE (PER MAPS)
CONDUIT			-	POWER RISER	ss		SANITARY SEWER LINE
PAVEMENT LEGEND PROPO	OSED 	30	-	TRAFFIC J-BOX	sp		STORM SEWER LINE
PAVEMENT LEGEND EXISTI	NG ⇒	•	-	POWER METER			CYCLONE FENCE LINE
CONCRETE SIDEWALK		+ ¥	_	PROPOSED LUMINAIRE	285		INDEX CONTOUR (5' INTERVAL)
SIDEWALK RAMP	4	+α	_	EXISTING LUMINAIRE		_	,
		gv .					CONTOUR LINE (1' INTERVAL)
		×	-	GAS VALVE	c/	L -	CENTERLINE
		AS	-	BIKE LANE			

VICINITY MAP

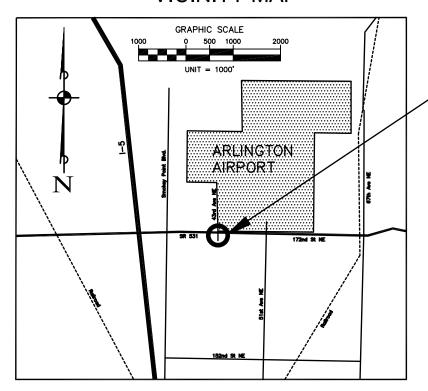

PROJECT LOCATION

CALL BEFORE YOU DIG

UTILITIES SHOWN ON THESE PLANS MAY BE BASED UPON UNVERIFIED PUBLIC INFORMATION AND ARE SUBJECT TO VARIATION. THE CONTRACTOR SHALL BE RESPONSIBLE FOR VERIFYING THE LOCATION, DIMENSION, AND DEPTH OF ALL EXISTING UTILITIES WHETHER SHOWN ON THESE PLANS OR NOT BY POTHOLING THE UTILITIES AND SURVEYING THE HORIZONTAL AND VERTICAL LOCATION PRIOR TO CONSTRUCTION. THIS SHALL INCLUDE TELEPHONING UTILITY LOCATE @ 1-800-424-5555 AND THEN POTHOLING ALL OF THE EXISTING UTILITIES AT LOCATIONS OF NEW UTILITY CROSSINGS TO PHYSICALLY VERIFY WHETHER OR NOT CONFLICTS EXIST. IF CONFLICTS SHOULD OCCUR, THE CONTRACTOR SHALL CONSULT HIGA BURKHOLDER AND ASSOCIATES, LLC TO RESOLVE ALL PROBLEMS PRIOR TO PROCEEDING.

SR-531 (172ND STREET NE) MP +/- 7.12, WHIDBEY ISLAND BANK BRANCH DEVELOPMENT SITE

NW 1/4, SEC 28, TWP 31 N, R 5 E, W. M., CITY OF ARLINGTON, SNOHOMISH COUNTY, WASHINGTON

> TRAFFIC SIGNAL AS BUILT PLANS, FOR APPROVAL JUNE 2009

INDEX OF DRAWINGS

TS-1 ... COVER SHEET

TS-2A ...TRAFFIC SIGNAL PLAN (WSDOT)

TS-2B ...TRAFFIC SIGNAL PLAN (WSDOT)

TS-2C ...ILLUMINATION PLAN (CITY)

TS-2D ...TRAFFIC SIGNAL PLAN (CORNER DETAIL - WSDOT & CITY)

TS-3 ... WIRING DIAGRAM

TS-4 ... POLE STANDARDS

TS-5 ... SCHEDULES

TS-6 ... TEMPORARY VIDEO DETECTION

TS-6A... VIDEO DETECTION DETAIL

TS-7... NOTES

TS-8 ... INPUT DIAGRAM

TS-9 ... WIRING TERMINATIONS

TS-10 ... CROSS SECTIONS

TS-11 ... FUTURE WIDENING OVERLAY

TS-12 ... INTERCONNECT SCHEMATIC

AS-BUILT DRAWING APPROVAL ACKNOWLEDGMENT

THIS AS-BUILT PLAN SHEET HAS BEEN REVIEWED AND ACCEPTED AS A RECORD DRAWING. THE LICENSED DESIGN ENGINEER WHOSE STAMP AND SIGNATURE APPEAR ON THIS SHEET ASSUMES FULL AND COMPLETE RESPONSIBILITY FOR THE ACCURACY THEREIN.

City Engineer, City of Arlington

WSDOT NORTHWEST REGION

APPROVED		DATE
ADDA TRAPPIC	PMCIMPPD	

R MANAGER DATE

8250 - 165th Avenue NE, Suite 1 Redmond, Washington 98052-66 (425) 883-4134 | www.tsinw.con Transportation Solutions, Inc

TRAFFIC SIGNAL PLANS WHIDBEY ISLAND BANK BRANCH DEVELOPMENT


D DE STATE OF STATE O

DATE | 6/2/09
DRAWN | SAC
DESIGNED | ADD
CHECKED | ADD
PROJECT # | 205004

SHEET TITLE

COVER SHEET

TS—1

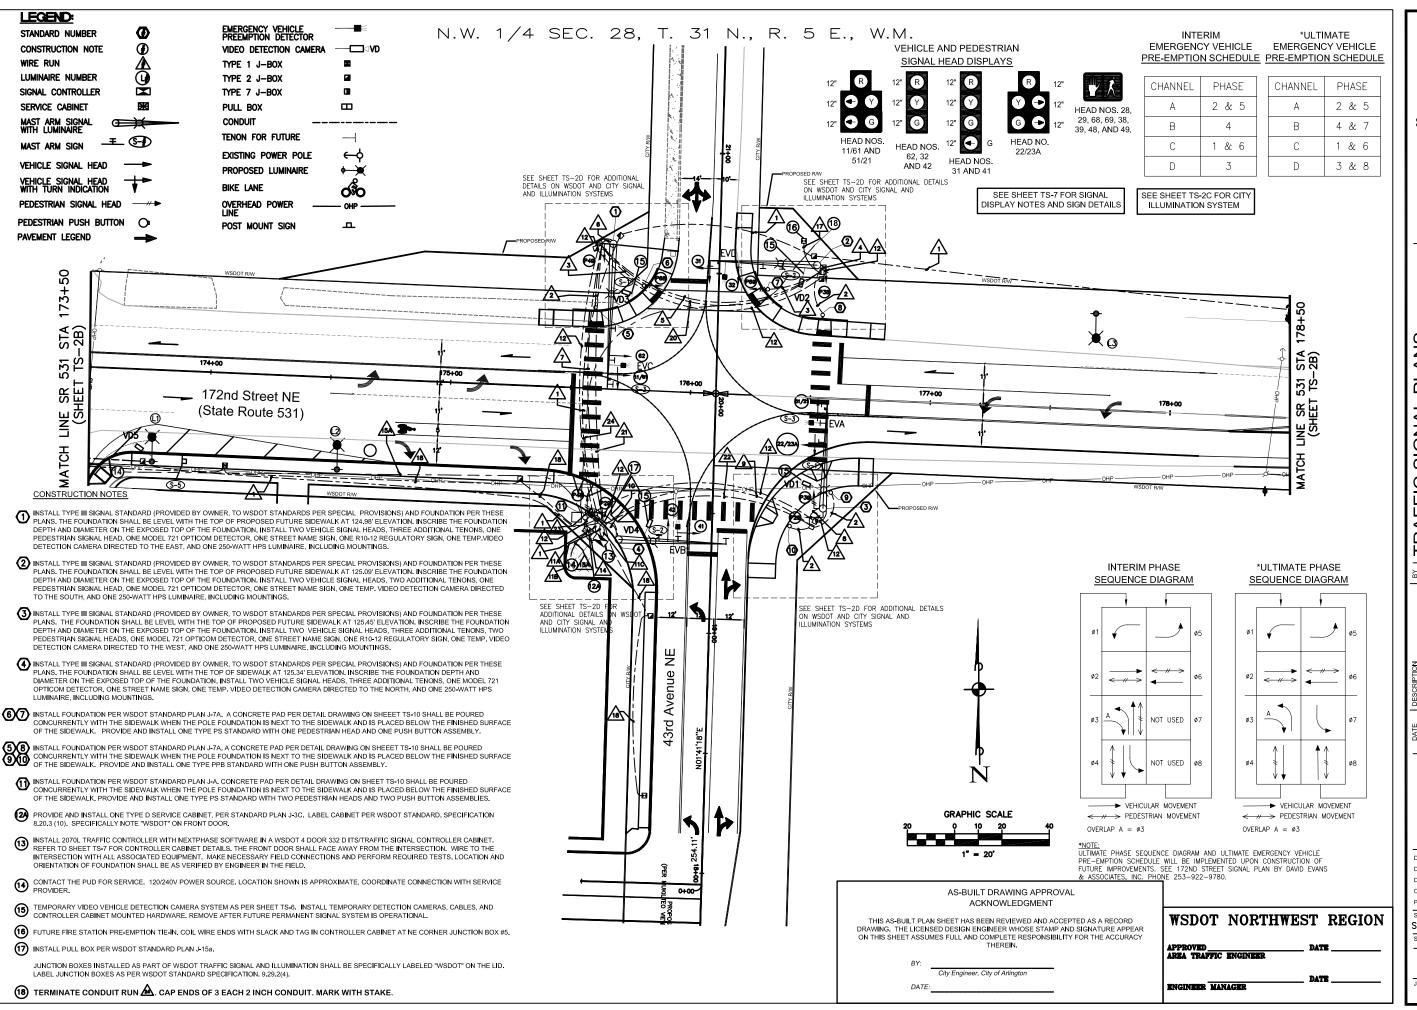

<u>2</u> 134 | www.tsinw | Solutions,

ANK \mathbf{m} AND PLAN SIGNAL <u>S</u> DĒ Ш \mathbf{m} BRANCH WHIDE TRAI


VELOPMEN'

SHINGTON

6/2/09 DRAWN | SAC DESIGNED | ADD CHECKED I ADD

PROJECT# | 205004 SHEET TITLE TRAFFIC SIGNAL PLAN (WSDOT)

SHEET NUMBE

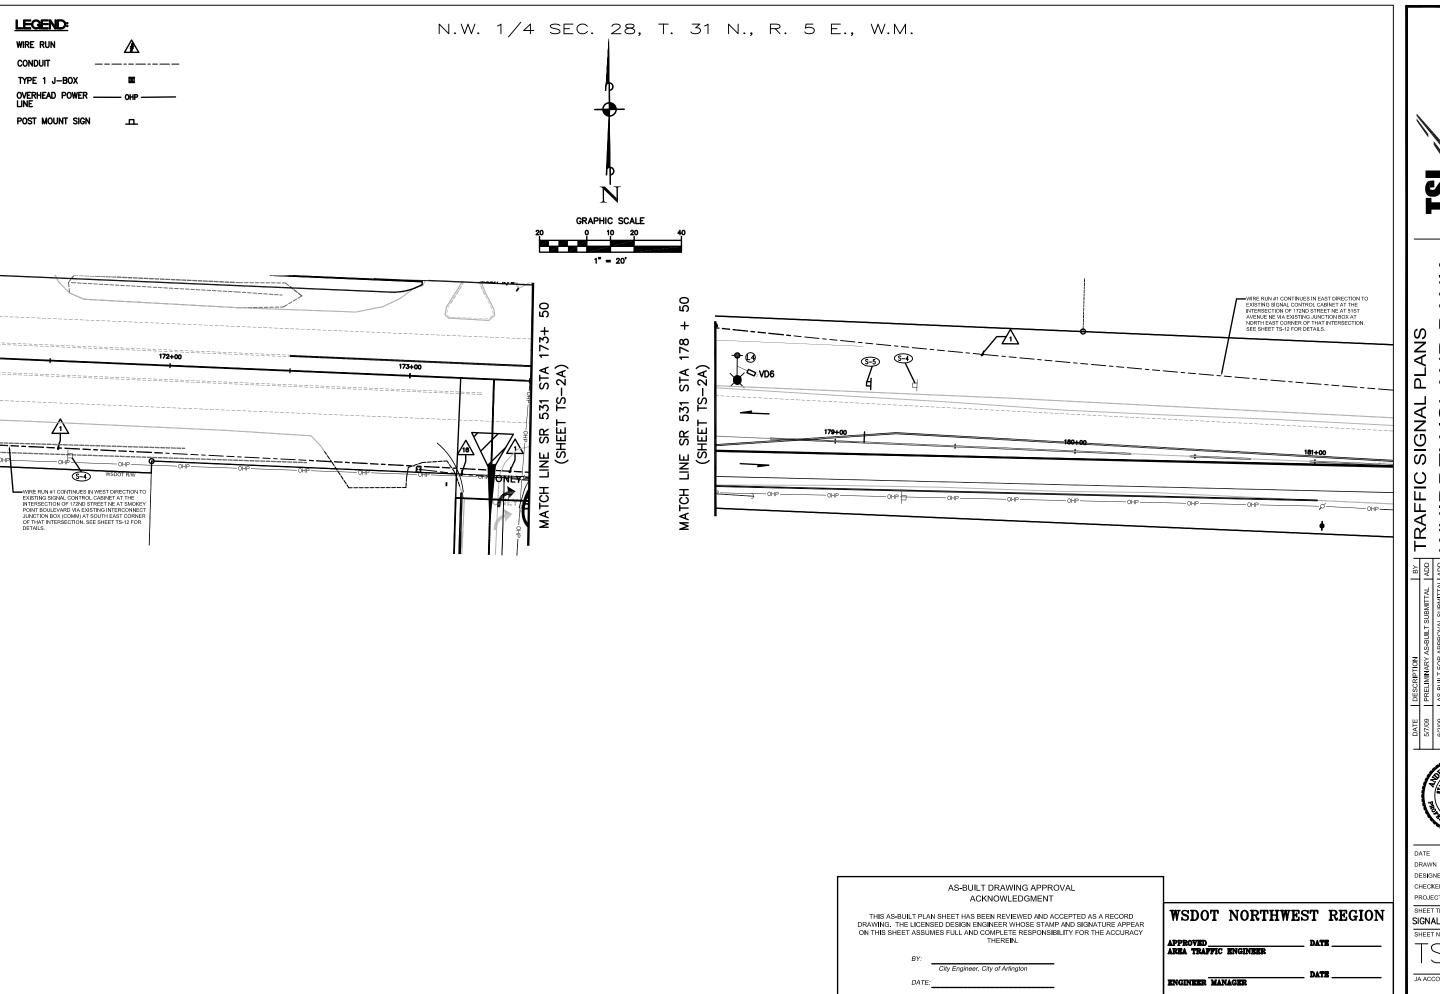


TRAFFIC SIGNAL PLANS
WHIDBEY ISLAND BANK
BRANCH DEVELOPMENT

DRAWN DESIGNED | ADD CHECKED ADD PROJECT# | 205004

SHEET TITLE TRAFFIC SIGNAL PLAN (WSDOT)

SHEET NUMBER

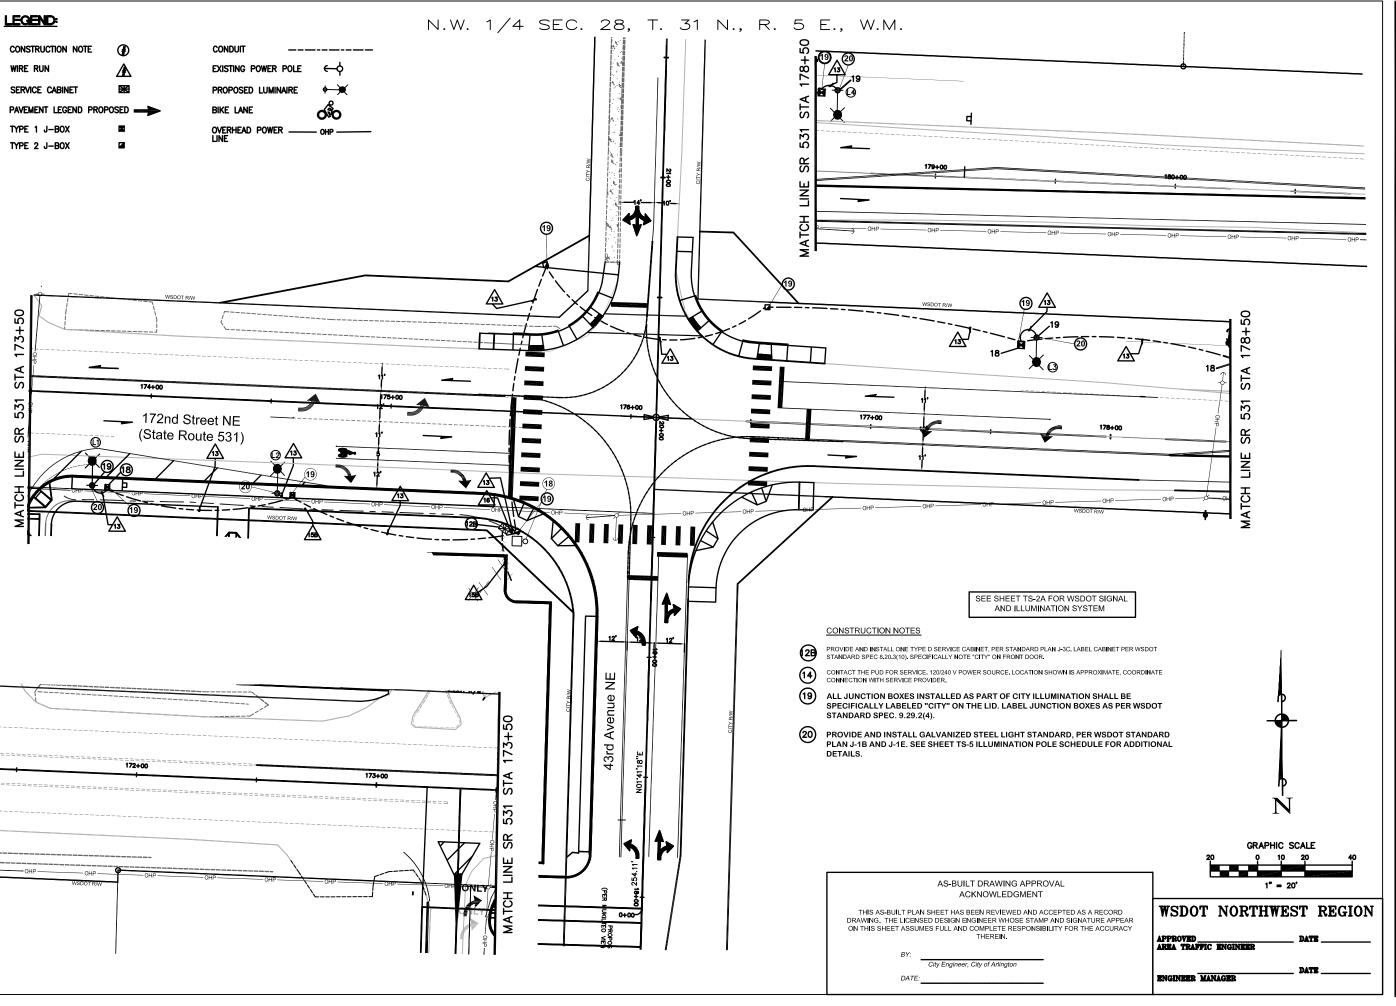



TRAFFIC SIGNAL PLANS
WHIDBEY ISLAND BANK

BRANCH DEVELOPMENT


5/7/09 PRELIMINARY AS 6/2/09 AS-BUILT FOR A


DATE | 6/2/09
DRAWN | SAC
DESIGNED | ADD
CHECKED | ADD


PROJECT# | 205004


SHEET TITLE | ILLUMINATION PLAN (CITY)

SHEET NUMBER

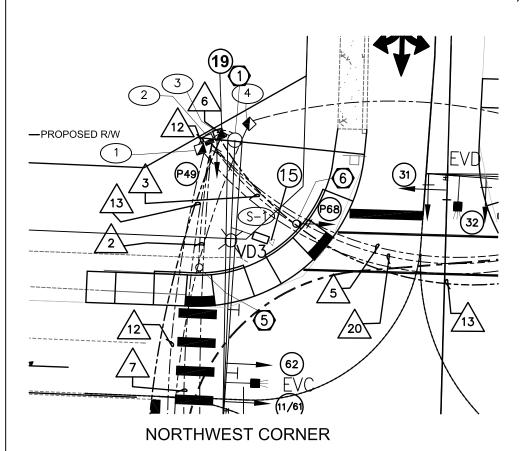

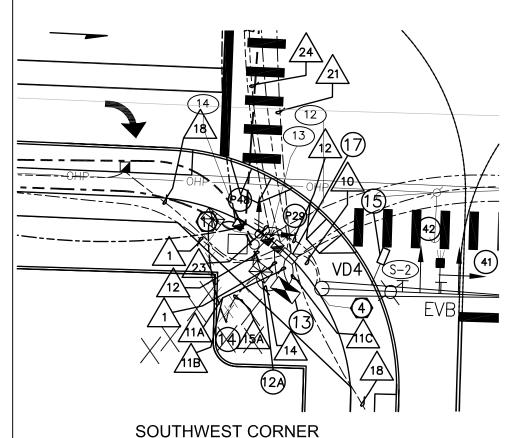

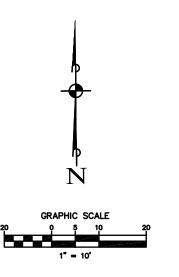


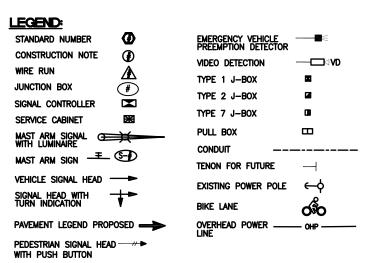


SEE CONSTRUCTION NOTES ON SHEET
TS-2A FOR WSDOT SIGNAL AND ILLUMINATION
SYSTEM AND SHEET TS-2C FOR CITY
ILLUMINATION SYSTEM

DETAILS OF JUNCTION BOXES NEAR THE CORNERS

JUNCTION BOX NUMBER	TYPE	ROAD	STATION	OFFSET TO CL
1	TYPE 2	172nd St NE	175+58.1	58.3' LT
2	TYPE 7	172nd St NE	175+59.8	60.3' LT
3	TYPE 2	172nd St NE	175+61.8	61.6' LT
4	TYPE 2	172nd St NE	175+68.1	64.0' LT
5	TYPE 1	172nd St NE	176+44.5	65.1' LT
6	TYPE 2	172nd St NE	176+49.0	58.9' LT
7	TYPE 7	172nd St NE	176+52.5	52.4' LT
8	TYPE 2	172nd St NE	176+52.6	49.5' LT
9	TYPE 2	172nd St NE	176+54.9	47.8' LT
10	TYPE 2	172nd St NE	176+54.2	51.4' RT
11	TYPE 7	172nd St NE	176+52.8	53.7' RT
12	TYPE 2	172nd St NE	175+63.1	54.1' RT
13	TYPE 2	172nd St NE	175+60.9	52.7' RT
14	TYPE 2	172nd St NE	175+54.9	49.8' RT
15	PULL BOX	172nd St NE	175+65.44	56.0' RT

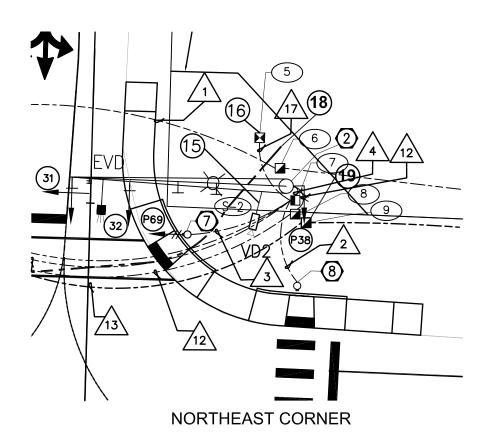

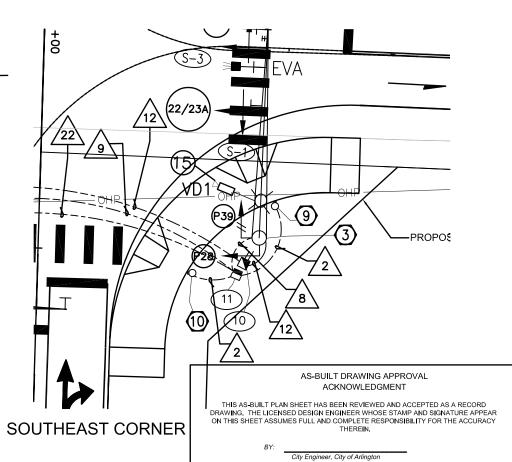



TRAFFIC SIGNAL PLANS
WHIDBEY ISLAND BANK
BRANCH DEVELOPMENT

TE DESCRIPTION

1009 | PRELIMINARY AS-BUILT SUBMITTAL |

1009 | AS-BUILT FOR APPROVAL SUBMITTAL SUBMIT


8V 6002/9


DATE | 6/2/09
DRAWN | SAC
DESIGNED | ADD
CHECKED | ADD

CHECKED | ADD
PROJECT# | 205004
SHEET TITLE

TRAFFIC SIGNAL PLAN
SHEET NUMBER

TS-2I

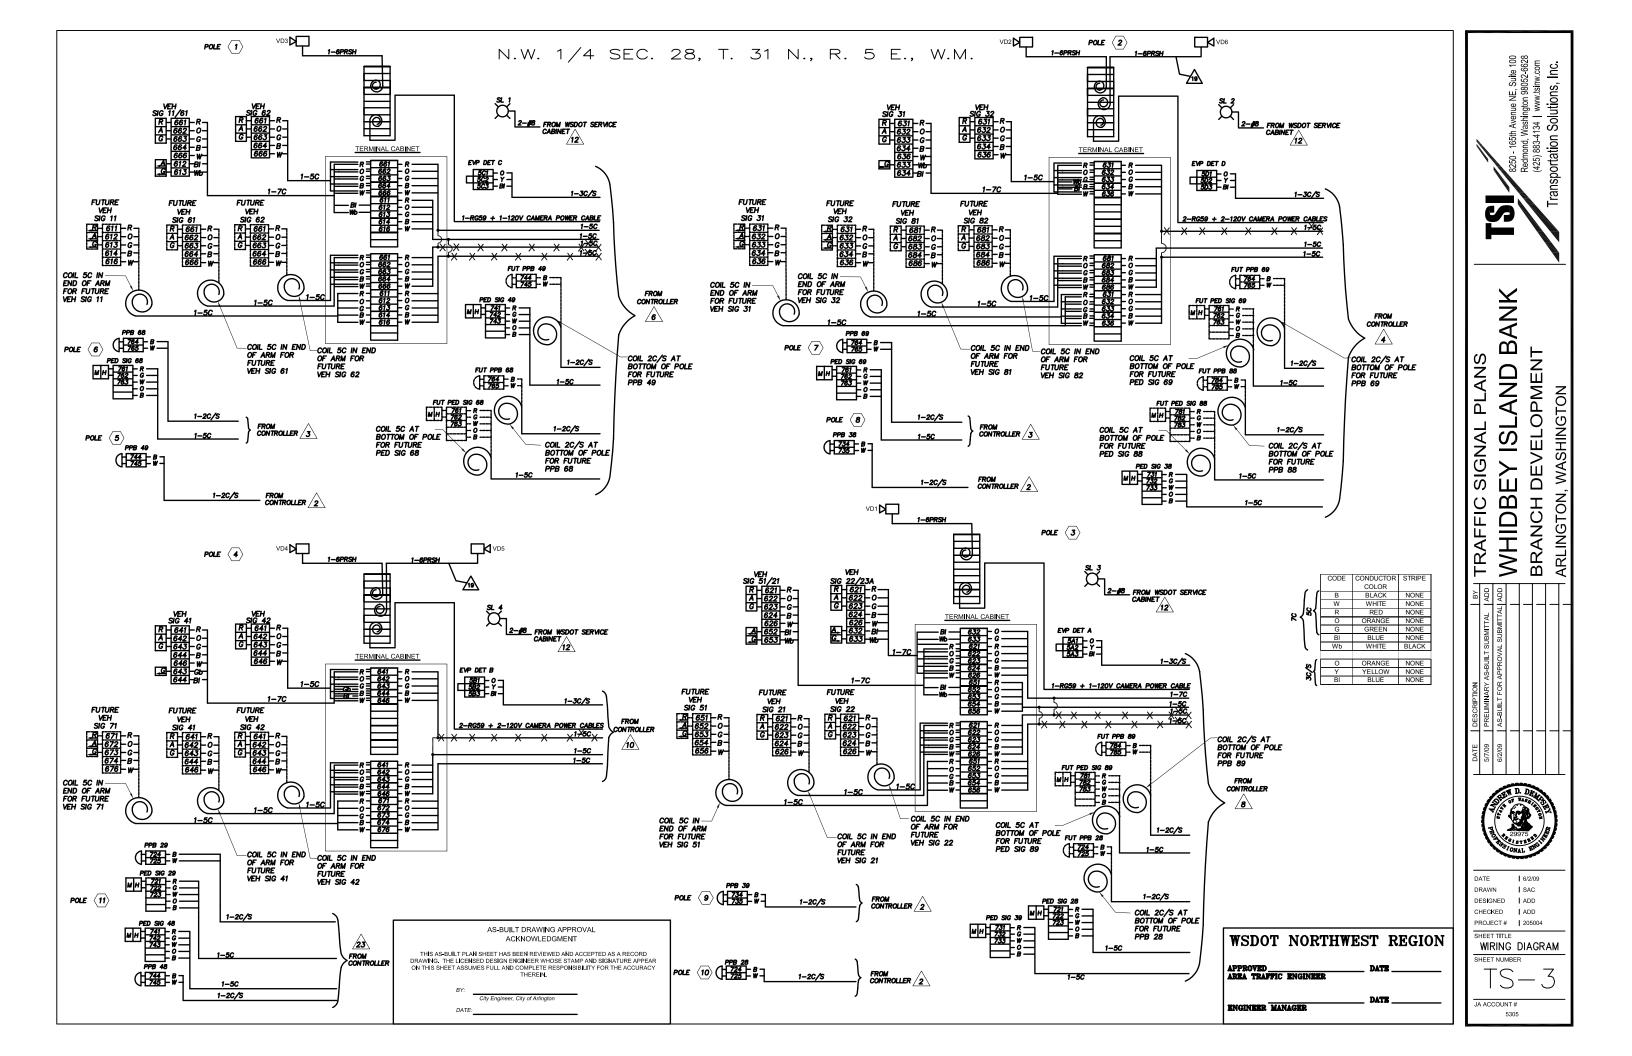

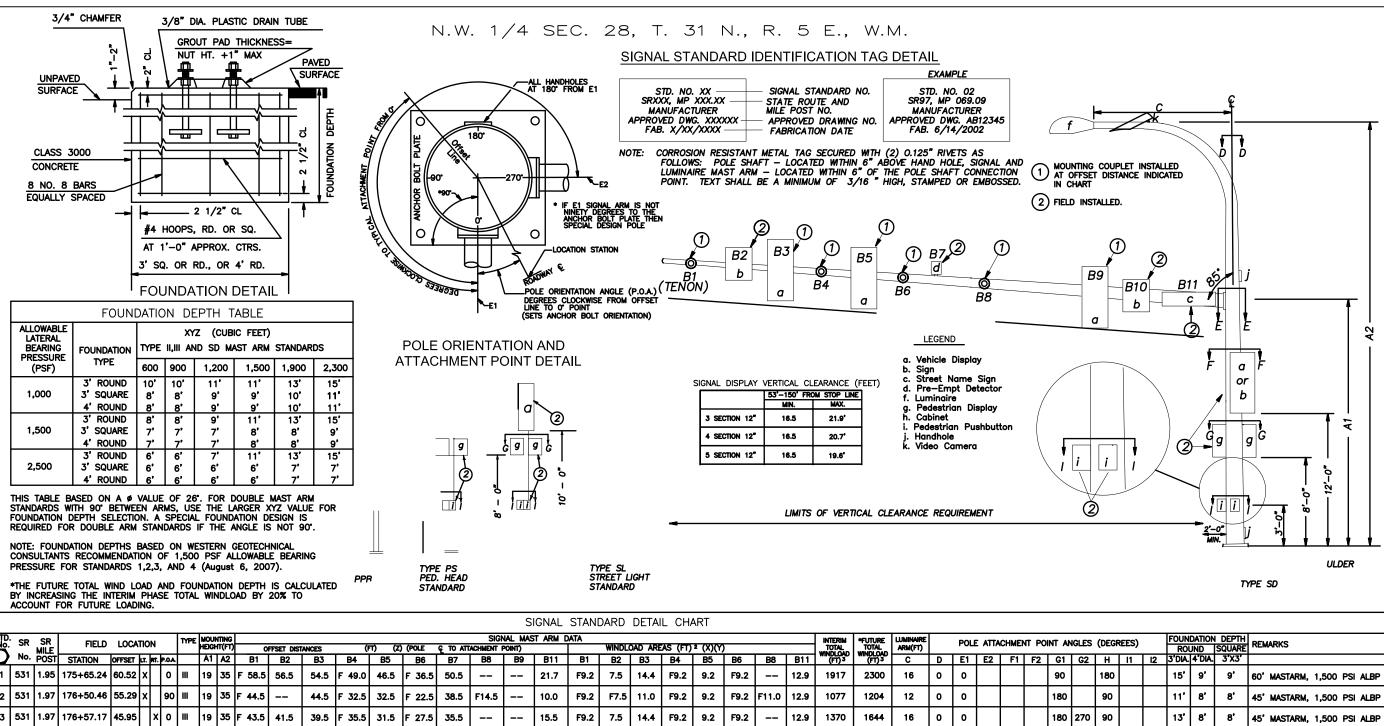

2 531 3 531 4 531 1.95 | 175+72.69 | 62.46 | |x|90|III 19 35 F 44.7 28.5 F 24.8 20.5 16.8 24.5 11.0 F9.2 F7.5 11.0 F9.2 9.2 F9.2 12.9 657 936 12 0 180 __ 45' MASTARM, 1,500 PSI ALBP --5 531 1.95 | 175+58.92 | 33.75 | X | 0 PER WSDOT STD PLAN J-7a 270 6 531 1.95 175+78.81 43.73 X 270 PER WSDOT STD PLAN J-7a 90 7 | 531 1.97 176+30.44 |44.31 |X| 0 PS PER WSDOT STD PLAN J-7a 8 531 1.97 | 176+53.60 | 34.64 | X | 0 PER WSDOT STD PLAN J-7a 0 531 1.97 176+60.16 39.20 PER WSDOT STD PLAN J-7a 10 531 1.97 | 176+43.57 | 53.84 270 PER WSDOT STD PLAN J-7a 11 531 1.95 | 175+59.05 | 51.76 0 90 PER WSDOT STD PLAN J-7a

NOTES

F# - FUTURE

ALTERNATE NOTE 1 FOR TYPE N MOUNT ONLY

HOLE IN MAST ARM AND INSTALL PLASTIC SPLIT BUSHING FOR CABLE ENTRANCE.

AS-BUILT DRAWING APPROVAL ACKNOWLEDGMENT

THIS AS BUILT PLAN SHEET HAS BEEN REVIEWED AND ACCEPTED AS A RECORD DRAWING, THE LICENSED DESIGN ENOINER WHOSE STAMP AND SIGNATURE APPEAR ON THIS SHEET ASSUMES FULL AND COMPLETE RESPONSIBILITY FOR THE ACCURACY THEREIN.

City Engineer, City of Arlington

WSDOT NORTHWEST REGION

ENGINEER MANAGER

5

PROJECT#

JA ACCOUNT #

Redmond, Washington 98052-(425) 883-4134 | www.tsimw.c Transportation Solutions, Ir

Y

1

 $\mathbf{\Omega}$

AND

 \overline{S}

 $\mathbf{\omega}$

MHIDI

PLANS

SIGNAL

TRAFFIC

EVELOPMENT

BRANCH

DATE I 6/2/09 DRAWN I SAC DESIGNED I ADD CHECKED I ADD

205004 SHEET TITLE POLE STANDARDS SHEET NUMBER

CONDUIT/WIRE SCHEDULE

								1						
RUN NO.	DIAMETER, INCHES	SERVICE (4/0)	POWER (#6)	GROUND (#8)	ILLUM. (#8)	PED PUSH BUT. (2CS-#14)	EMER. PRE- EMPT/ ILL.SIGN (3CS#20)	VEH. OR PED HEADS (5C)	VEH. OR PED. HEADS (7C)	COAX CABLE RG59	120 V CAMERA POWER 3C	INTERCONNECT FO 12 Conductor	RUN NO.	REMARKS
1	2.00			1								1	1	ALLOWS FOR SR-531 INTERCONNECT. SEE SHEET TS-12 FOR DETAILS.
2	2.00			1		1							2	PUSH BUTTONS (JB 2 TO STD 5, JB 7 TO STD 8, JB11 TO STD 9,10)
3	2.00			1		1		1					3	PUSH BUTTONS (JB 2 TO POLE 6, JB 7 TO POLE 7)
4	3.00			1		2	1	6		2	2		4	JB 7 TO SIGNAL POLE 2
5	3.00			1		4	2	7					5	CROSSES 43RD AVE NE NORTH (JB 2 TO JB 7)
6	3.00			1		2	1	6		1	1		6	JB 2 TO SIGNAL POLE 1
7	4.00			1		8	3	14					7	CROSSES 172ND ST NE WEST (JB2 TO PULL BOX)
8	3.00			1		2	1	6	1	1	1		8	JB 11 TO SIGNAL POLE 3
9	4.00			1		4	1	6	1				9	CROSSES 43RD AVE NE SOUTH (JB11 TO PULLBOX)
10	3.00			1			1	3		2	2		10	PULL BOX TO SIGNAL POLE 4
11A	4.00			1		8	3	13					11A	CONTROLLER CABINET TO PULL BOX
														SPARE WITH PULL STRING FOR FUTURE LOOP
11B	3.50									6	6		11B	DETECTION. REMOVE THE VIDEO CABLE ONCE THE
														FUTURE PERMANENT SIGNAL IS OPERATIONAL
11C	3.50					6	2	12	1				11C	CONTROLLER CABINET TO PULL BOX
12	2.00			1	2								12	ILLUMINATION (WSDOT)
13	2.00			1	2								13	ILLUMINATION (CITY)
14	2.00		3										14	SERVICE CABINET TO CONTROLLER CABINET
15A	3.00	3											15A	SERVICE CABINET (WSDOT) TO POWER SOURCE
15B	3.00	3											15B	SERVICE CABINET (CITY) TO POWER SOURCE
17	2.00			1			1						17	EMER. PRE-EMPT. FOR FUT. FIRE STATION
18	2.00												18	SPARE WITH PULL STRING FOR FUTURE LOOP DETECTION.
19	AERIAL									1	1		19	SEE CONSTRUCTION NOTE 2 ON SHEET TS-6 FOR DETAILS.
														SPARE WITH PULL STRING FOR FUTURE LOOP
20	3.00									2	2		20	DETECTION. REMOVE THE VIDEO CABLE ONCE THE
														FUTURE PERMANENT SIGNAL IS OPERATIONAL
														SPARE WITH PULL STRING FOR FUTURE LOOP
21	3.00									3	3		21	DETECTION. REMOVE THE VIDEO CABLE ONCE THE
														FUTURE PERMANENT SIGNAL IS OPERATIONAL
														SPARE WITH PULL STRING FOR FUTURE LOOP
22	3.00									1	1		22	DETECTION. REMOVE THE VIDEO CABLE ONCE THE
														FUTURE PERMANENT SIGNAL IS OPERATIONAL
23	2.00			1		2		2					23	PED HEADS AND PUSH BUTTONS (PULLBOX TO POLE 11)
24	(3) 2.00												24	3 EACH 2 INCH SPARE FOR BLACK ROCK CABLE

CONDUIT NOTES

ALL CONDUIT BELOW ROADWAY SHALL BE PVC SCHEDULE 80. CONDUIT RUN 15A AND 15B (POWER SOURCE) SHALL BE GALVANIZED STEEL. ALL OTHER CONDUIT MAY BE PVC SCHEDULE 40.
ALL CONDUIT CROSSING SR 531 SHALL BE INSTALLED USING THE DIRECTIONAL BORING METHOD.

	ILLUMINATION POLE SCHEDULE											
LUM. POLE NO.**	ROAD	STATION	OFFSET		ARM LENGTH	CIRCUIT	WATT./ TYPE	PHOTO- METRICS	POLE TYPE	BASE		
L1	SR-531	173+77	RT 38'	40'	8'	ILLUM	400/III	MEDIUM-CUTOFF	G. STEEL	SLIP		
L2	SR-531	174+54	RT 38'	40'	8'	ILLUM	400/III	MEDIUM-CUTOFF	G. STEEL	SLIP		
L3	SR-531	177+68	LT 40'	40'	8'	ILLUM	400/III	MEDIUM-CUTOFF	G. STEEL	SLIP		
L4	SR-531	178+58	LT 40' 34'	40'	8'	ILLUM	400/III	MEDIUM-CUTOFF	G. STEEL	SLIP		

WSDOT SERVICE

	BREAKER SCHEDULE 240V - 120/240V TYPE-D SERVICE											
CIRCUIT	DESCRIPTION	BREAKER	CONTACTOR	VOLTAGE	LOAD							
		RATING	RATING		(KVA)							
	MAIN	200 AMP	N/A	240	Х							
S1	SIGNAL	50 AMP	N/A	120	2.340							
C1	SPARE	30 AMP	N/A	120	0.000							
C2	SPARE	30 AMP	N/A	120	0.000							
L1	LIGHTING	30 AMP	30 AMP	240	1.880							
L2	SPARE	30 AMP	30 AMP	240	0.000							
L3	SPARE	30 AMP	30 AMP	240	0.000							
C3	GFCI	20 AMP	N/A	120	1.800							
C4	PHOTOCELL	15 AMP	N/A	120	0.001							
C5	HEAT STRIP	15 AMP	N/A	120	0.100							
C6	SPARE	30 AMP	N/A	120	0.000							
BUSS	WORK SHALL BE	RATED	PEAK		Х							
A	T 250 AMP MININ	<u></u>	CONTINUOUS		Х							

CITY SERVICE

	BREAKER SCHEDULE											
	240V	- 120/240V TYI	PE-D SERVICE									
CIRCUIT	DESCRIPTION	BREAKER	CONTACTOR	VOLTAGE	LOAD							
Circon	DESCINI NON	RATING	RATING	VOLIAGE	(KVA)							
	MAIN	200 AMP	N/A	240	Х							
S1	SIGNAL	50 AMP N/A		120	0.000							
L1	LIGHTING	20 AMP	30 AMP	240	2.820							
L2	FUT. LIGHTING	20 AMP	30 AMP	240	0.000							
L3	FUT. LIGHTING	20 AMP	30 AMP	240	0.000							
C3	GFCI	20 AMP	N/A	120	1.800							
C4	PHOTOCELL	15 AMP	N/A	120	0.001							
C5	HEAT STRIP	15 AMP	N/A	120	0.100							
C6	C6 SPARE		N/A	120	0.000							
BUSS	WORK SHALL BE	ERATED	PEAK		Х							
A	T 250 AMP MININ	1UM	CONTINUOUS		Х							

AS-BUILT DRAWING APPROVAL ACKNOWLEDGMENT

THIS AS-BUILT PLAN SHEET HAS BEEN REVIEWED AND ACCEPTED AS A RECORD DRAWING. THE LICENSED DESIGN ENGINEER WHOSE STAMP AND SIGNATURE APPEAR ON THIS SHEET ASSUMES FULL AND COMPLETE RESPONSIBILITY FOR THE ACCURACY THEREIN.

BY:

City Engineer, City of Arlington

DATE:

WSDOT NORTHWEST REGION

APPROVEDAREA TRAFFIC ENGINEER	DATE
ENGINEED WANAGED	DATE

Redmond, Washington 88052-6628 (425) 883-4134 | www.isinw.com


TRAFFIC SIGNAL PLANS
WHIDBEY ISLAND BANK
BRANCH DEVELOPMENT

1 D. Dr.

DATE | 6/2/09
DRAWN | SAC
DESIGNED | ADD
CHECKED | ADD
PROJECT# | 205004

SCHEDULES

TS—!

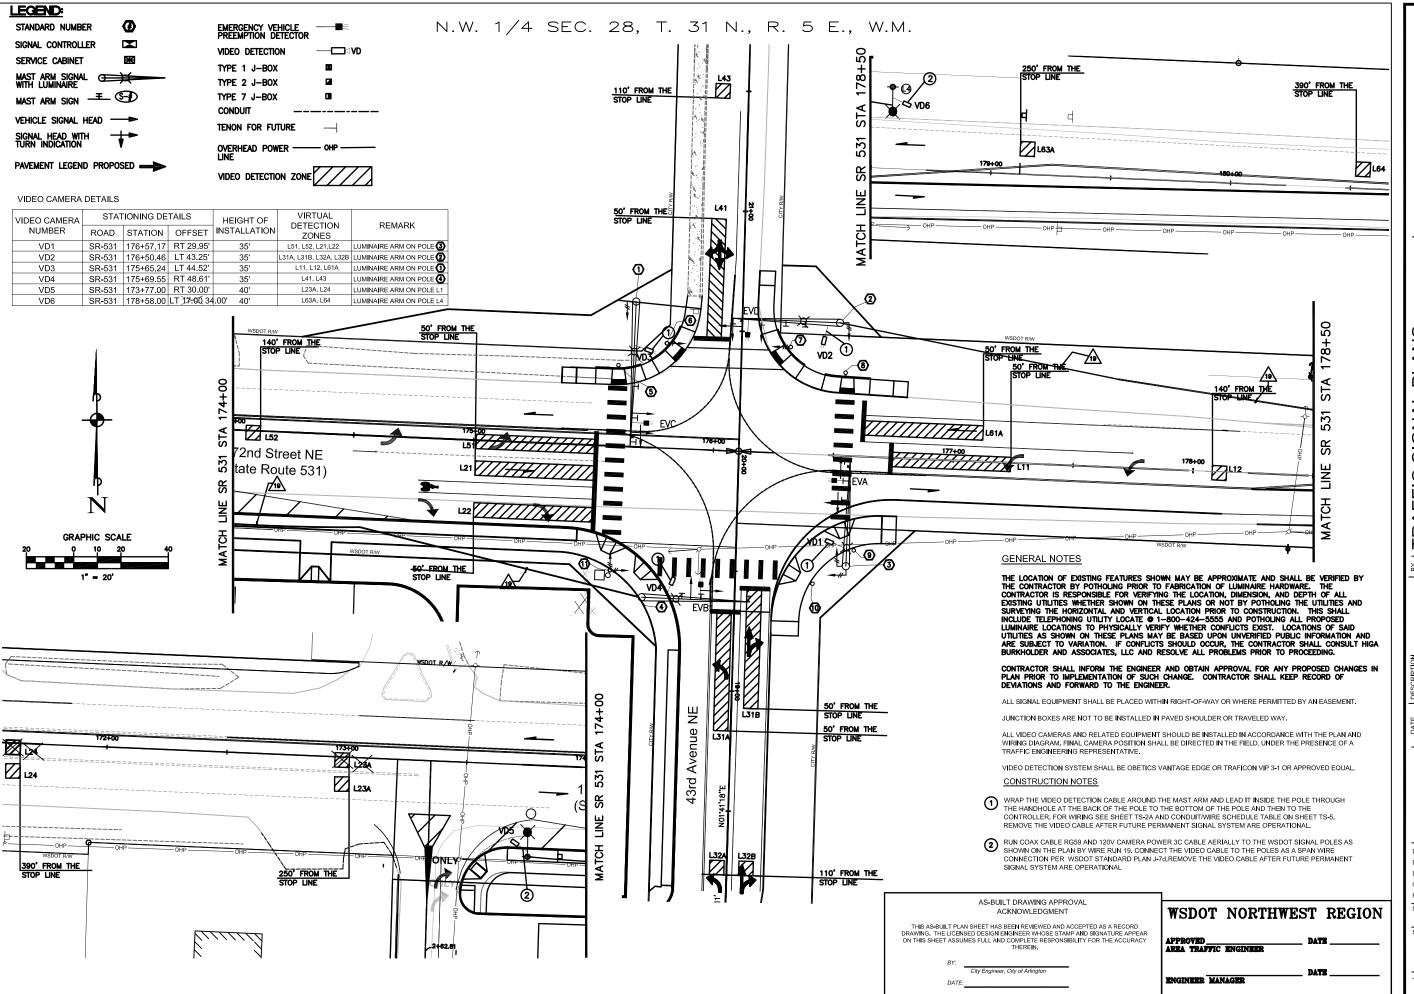



ANK \mathbf{m} DEVELOPMENT AND EY ISL/ SIGNAL WHIDB BRANCH TRAFFIC

WASHINGTON

ARLINGTON,


I 6/2/09 DRAWN DESIGNED ADD

LSAC CHECKED | ADD

PROJECT# | 205004 SHEET TITLE

TEMP. VIDEO DET. SHEET NUMBER

S

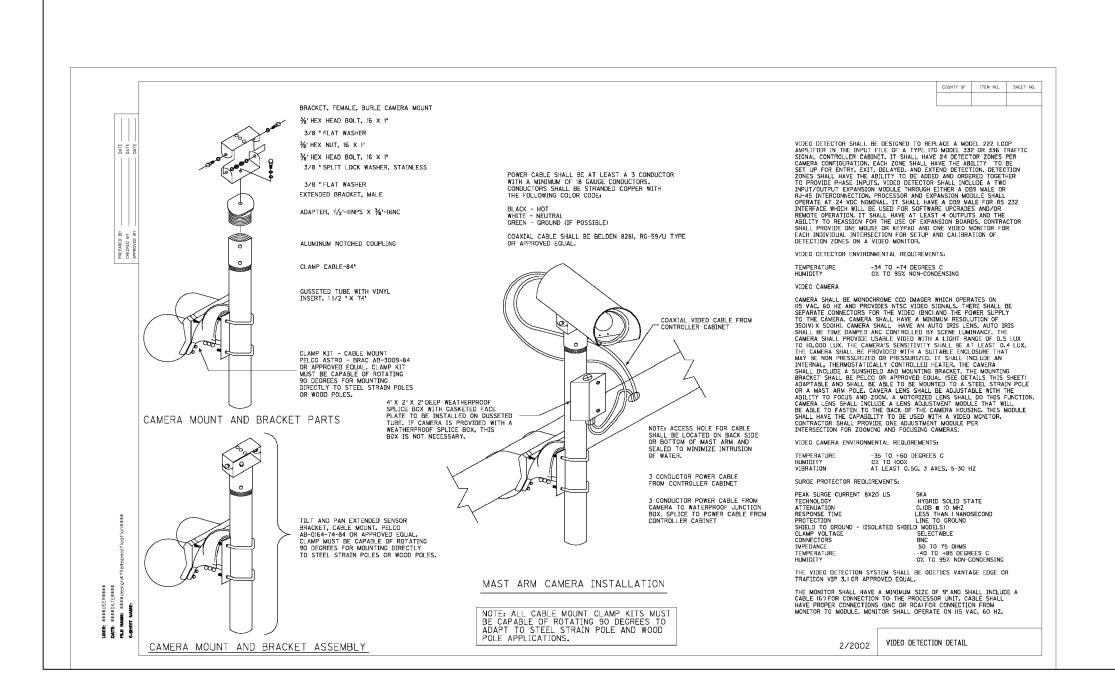

AS-BUILT DRAWING APPROVAL ACKNOWLEDGMENT

THIS AS-BUILT PLAN SHEET HAS BEEN REVIEWED AND ACCEPTED AS A RECORD DRAWING. THE LICENSED DESIGN ENGINEER WHOSE STAMP AND SIGNATURE APPEAR ON THIS SHEET ASSUMES FULL AND COMPLETE RESPONSIBILITY FOR THE ACCURACY THEREIN.

City Engineer, City of Arlington

WSDOT NORTHWEST REGION

APPROVED_____ DATE _____
AREA TRAFFIC ENGINEER

ENGINEER MANAGER

R250 - 165th Avenue NE. Suite 100 Redmond, Washington 98052-6628 (425) 883-4134 | www.tsinw.com Transportation Soluttions, Inc.

TRAFFIC SIGNAL PLANS
ALSUBMITTAL ADD

WHIDBEY ISLAND BANK
BRANCH DEVELOPMENT

WASHINGTON

ARLINGTON,



DATE | 6/2/09
DRAWN | SAC
DESIGNED | ADD
CHECKED | ADD
PROJECT # | 205004

VIDEO DET. DETAIL

TS-6A

GENERAL NOTES

THE LOCATION OF EXISTING FEATURES SHOWN MAY BE APPROXIMATE AND SHALL BE VERIFIED BY THE CONTRACTOR BY POTHOLING PRIOR TO FABRICATION OF LUMINAIRE HARDWARE. THE CONTRACTOR IS RESPONSIBLE FOR VERIFYING THE LOCATION, DIMENSION, AND DEPTH OF ALL EXISTING UTILITIES WHETHER SHOWN ON THESE PLANS OR NOT BY POTHOLING THE UTILITIES AND SURVEYING THE HORIZONTAL AND VERTICAL LOCATION PRIOR TO CONSTRUCTION. THIS SHALL INCLUDE TELEPHONING UTILITY LOCATE @ 1-800-424-5555 AND POTHOLING ALL PROPOSED LUMINAIRE LOCATIONS TO PHYSICALLY VERIFY WHETHER CONFLICTS EXIST. LOCATIONS OF SAID UTILITIES AS SHOWN ON THESE PLANS MAY BE BASED UPON UNVERIFIED PUBLIC INFORMATION AND ARE SUBJECT TO VARIATION. IF CONFLICTS SHOULD OCCUR, THE CONTRACTOR SHALL CONSULT HIGA BURKHOLDER AND ASSOCIATES, LLC AND RESOLVE ALL PROBLEMS PRIOR TO PROCEEDING.

CONTRACTOR SHALL INFORM THE ENGINEER AND OBTAIN APPROVAL FOR ANY PROPOSED CHANGES IN PLAN PRIOR TO IMPLEMENTATION OF SUCH CHANGE. CONTRACTOR SHALL KEEP RECORD OF DEVIATIONS AND FORWARD TO THE ENGINEER.

ALL SIGNAL EQUIPMENT SHALL BE PLACED WITHIN RIGHT-OF-WAY OR WHERE PERMITTED BY AN EASEMENT.

JUNCTION BOXES ARE NOT TO BE INSTALLED IN PAVED SHOULDER OR TRAVELED WAY.

SIGNAL DISPLAY NOTES

- 1) ALL VEHICLE AND PEDESTRIAN DISPLAYS SHALL BE LIGHT-EMITTING DIODES (LED).
- 2) ALL VEHICLE SIGNAL HEADS SHALL BE CONVENTIONAL TYPE WITH 12" LENSES, SQUARE DOORS, AND BE EQUIPPED WITH ALUMINUM TUNNEL VISORS AND BACKPLATES. HEADS SHALL BE PAINTED DARK GREEN, WITH FLAT BLACK INTERIORS.
- 3) ALL MASTARM MOUNTED SIGNAL HEADS SHALL USE TYPE M MOUNTING.
- 4) TYPE III STANDARD SIDE-MOUNT PEDESTRIAN HEAD SHALL BE TYPE E. TYPE PS STANDARD TOP-MOUNT PEDESTRIAN SINGLE- HEAD SHALL BE TYPE D. TYPE PS STANDARD TOP-MOUNT PEDESTRIAN DUAL-HEAD SHALL BE TYPE C.

SIGN DETAILS


- (S-1) INSTALL "43rd Ave NE" STREET NAME SIGN ON MAST ARM, 102" X 24".

 TEXT SIZES SHALL BE 12" UPPERCASE LETTERS WITH 9" LOWER CASE
 "D" SERIES LETTERS. LEGEND SHALL BE WHITE TYPE VIII REFLECTIVE
 SHEETING WITH BACKGROUND AS GREEN TYPE III REFLECTIVE
 SHEETING, WITH ALUMINIUM SUBSTRATE UNDER THE SHEETINGS.
- S-2) INSTALL "172ND ST NE" STREET NAME SIGN ON MAST ARM, 66" X 18".
 TEXT SIZES SHALL BE 8" IN CAPITAL "D" SERIES LETTERS. LEGEND
 SHALL BE WHITE TYPE VIII REFLECTIVE SHEETING WITH BACKGROUND
 AS GREEN TYPE III REFLECTIVE SHEETING, WITH ALUMINIUM
 SUBSTRATE UNDER THE SHEETINGS.
- (\$-3) INSTALL "LEFT TURN YIELD ON GREEN BALL" ON MAST ARM, MUTCD NO. R10-12, 30" \times 36". QUANTITY 2. SHEETING TYPE SHALL BE III.
- REMOVE "T-INTERSECTION" SIGNS AT APPROX. STA. 171+60, RT 39 AND 179+35, LT 25' ALONG SR 531.
- INSTALL "43RD AVENUE NE" D 3-301 POST MOUNT SIGNS, 54" X 12" AT STA. 179+12, LT 25' AND 173+82, RT 38' ALONG SR 531. EACH SIGN TO BE MOUNTED ON ONE STEEL POST. USE 4" SQUARE POST, WITH TYPE AS FOUNDATION AS PER WSDOT STD PLAN G-8A. TEXT SIZES SHALL BE 6" IN CAPITAL "D" SERIES LETTERS. LEGEND SHALL BE WHITE TYPE II REFLECTIVE SHEETING WITH BACKGROUND AS GREEN TYPE II REFLECTIVE SHEETING, WITH ALUMINIUM SUBSTRATE UNDER THE SHEFTINGS


43rd Ave NE

172ND ST NE



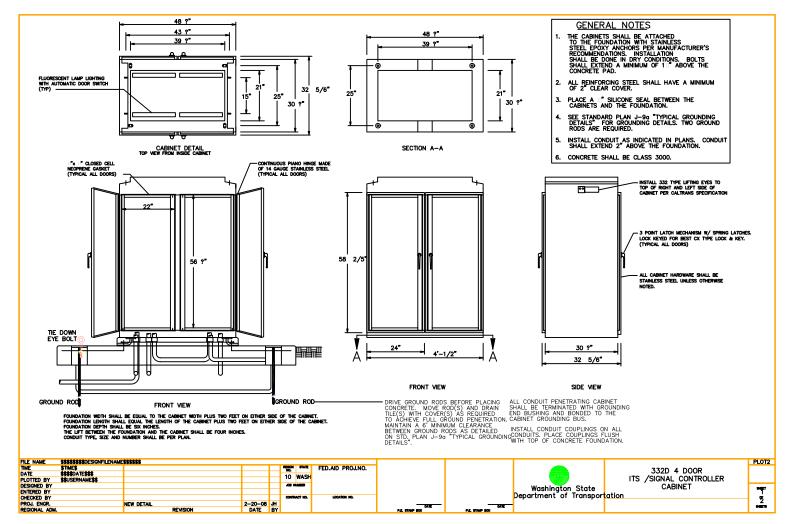

CONTROLLER CABINET DETAIL

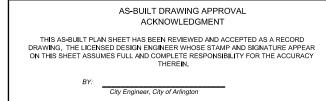

WSDOT NORTHWEST REGION

PROVED		DATE
BA TRAPPIC	ENGINEER	

engineer <u>wanager</u>

8250 - 165th Avenue NE, Suite 10 Redmond, Washington 98052-665 (425) 883-4134 | www.tsinw.com Transportation Solutions, Inc.

TRAFFIC SIGNAL PLANS WHIDBEY ISLAND B, BRANCH DEVELOPMENT


ANK

5/1	7/9				
j.	SIRE SIRE	N D	Di		
		299		3	` *
1		ION	175 14 E	ie i	

	DATE	6/2/09
	DRAWN	SAC
	DESIGNED	ADD
	CHECKED	ADD
	PROJECT#	20500
1	SHEET TITLE	

NOTES SHEET NUMBER

TS-7

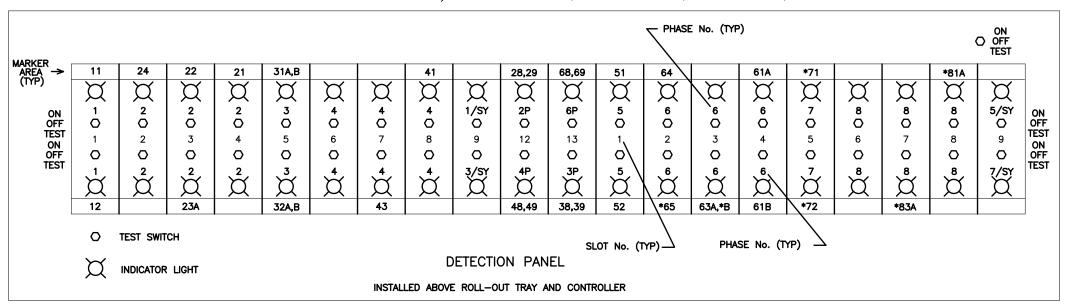


INPUT FILE LAYOUT

	1	2	3	4	5	6	7	8	Ø1E,C	10	11	12	13	14
	Ø1E,C	Ø2E,C	Ø2E,C	Ø2C	Ø3E,C	Ø4E,C	Ø4E,C	Ø4C	DARKE			Ø2P	Ø6P	FLH
U														
												1 20 20	60 60	
	VD3 *L11	VD5 *L24	VD1 *L22	VD1 *L21	VD2 L31A,B			VD4 *L41				1 20.23	 	
1	*L12		*L23A VD5		L32A,B		*L43					48-49	38-39	
	VD3		VD5		VD2		VD4							
L	222	222	222	222	222	222	222	222	222			242	242	
	Ø1E,C	Ø2E,C	Ø2E	Ø2C	Ø3E,C	Ø4E,C	Ø4E	Ø4C	Ø3E,C			Ø4P	Ø3P	ST
	Ø5E,C	Ø6E,C	Ø6E,C	Ø6C	Ø7E,C	Ø8E,C	Ø8E,C	Ø8C	Ø5E,C			EVA	EVB	
U														
	VD1 *L51	VD6 *L64		VD3 *L61A	*L71			*L81A					В	
J	*L52		*L63A,B	*L61B			*L83A					i c	□	
	VD1		VD6											
L	222	222	222	222	222	222	222	222	222					
_	Ø5E,C	Ø6E,C	Ø6E	Ø6C	Ø7E,C	Ø8E,C	Ø8E	Ø8C	Ø7E,C			EVC	EVD	


*I OOP DETECTORS TO BE USED IN FUTURE SEE 172ND STREET SIGNAL PLAN BY DAVID EVANS & ASSOCIATES, INC. PHONE

INTERIM PHASE SEQUENCE DIAGRAM

OVERLAP A = Ø3

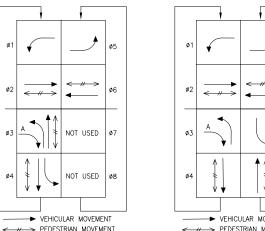

*ULTIMATE PHASE SEQUENCE DIAGRAM

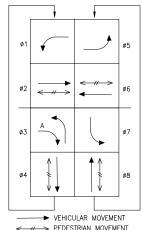

OVERLAP A = Ø3

INTERIM EMERGENCY VEHICLE PRE-EMPTION SCHEDULE PRE-EMPTION SCHEDULE


CHANNEL	PHASE	CHANNEL	PHASE
А	2 & 5	А	2 & 5
В	4	В	4 & 7
С	1 & 6	С	1 & 6
D	3	D	3 & 8

*ULTIMATE

EMERGENCY VEHICLE


*NOTE:
ULTIMATE PHASE SEQUENCE DIAGRAM AND ULTIMATE EMERGENCY VEHICLE PRE-EMPTION SCHEDULE WILL BE IMPLEMENTED UPON CONSTRUCTION OF FUTURE IMPROVEMENTS. SEE 172ND STREET SIGNAL PLAN BY DAVID EVANS & ASSOCIATES, INC. PHONE 253–922–9780.

MODULE

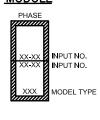





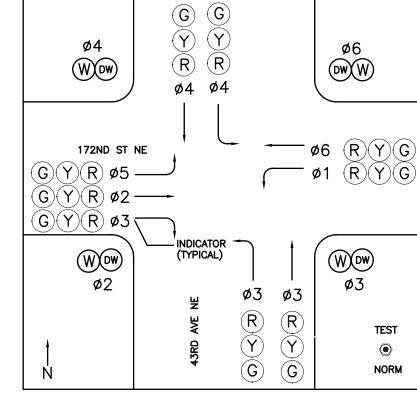

DISPLAY PANEL CONFIGURATION

AS-BUILT DRAWING APPROVAL ACKNOWLEDGMENT

THIS AS-BUILT PLAN SHEET HAS BEEN REVIEWED AND ACCEPTED AS A RECORD DRAWING. THE LICENSED DESIGN ENGINEER WHOSE STAMP AND SIGNATURE APPEAR ON THIS SHEET ASSUMES FULL AND COMPLETE RESPONSIBILITY FOR THE ACCURACY THEREIN.

City Engineer, City of Arlington

WSDOT NORTHWEST REGION

APPROVED_ AREA TRAFFIC ENGINEER ENGINEER MANAGER



ANK $\mathbf{\Omega}$ BRANCH DEVELOPMENT **EY ISLAND** SIGNAL WHIDBI


ARLINGTON, WASHINGTON


I 6/2/09 DATE DRAWN | SAC DESIGNED | ADD CHECKED | ADD PROJECT# | 205004


SHEET TITLI INPUT DIAGRAM


SHEET NUMBER TS-8


CABINET WIRE TERMINATIONS

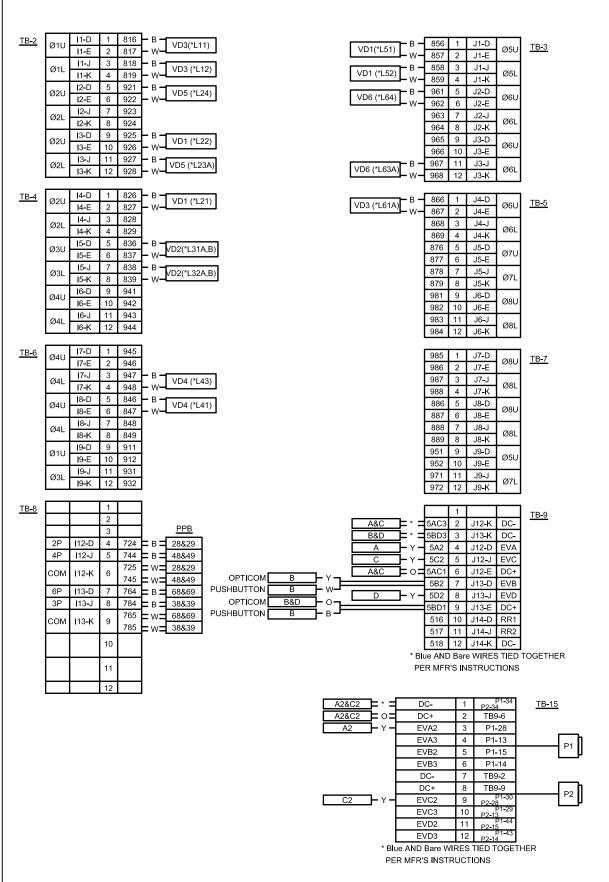

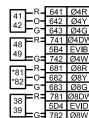

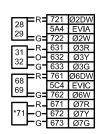

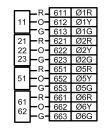

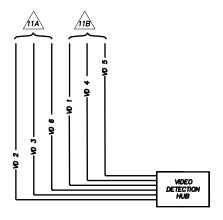

SERVICE PANEL



NOTES

- 1. TERMINATE ALL WIRING IDENTIFIED AS AC (6*6, 7*3 AND V*2) IN THE FIELD WIRING CHART AND THE WIRING SCHEMATIC AT THE NEUTRAL GROUND BUSS.
- 2. TERMINATE ALL SPARE WIRING (6*4, 7*6 AND 7*7) AT A SPARE TERMINAL BUSS. THE * DENOTES THE PHASE NUMBER.
- TERMINATE ALL OTHER SPARE WIRING AT THE CONTROLLER AND DISPLAY OR DETECTION DEVICE, SEAL WITH HEAT SHRINK END CAP AND COIL 5 EXTRA FEET AT EACH LOCATION.

CONTRACTOR SHALL FURNISH AND INSTALL NEXTPHASE SOFTWARE.

*LOOP DETECTORS TO BE USED IN FUTURE. SEE 172ND STREET SIGNAL PLAN BY DAVID EVANS & ASSOCIATES, INC. PHONE 253-922-9780.

AS-BUILT DRAWING APPROVAL ACKNOWLEDGMENT

THIS AS-BUILT PLAN SHEET HAS BEEN REVIEWED AND ACCEPTED AS A RECORD DRAWING. THE LICENSED DESIGN ENGINEER WHOSE STAMP AND SIGNATURE APPEAR ON THIS SHEET ASSUMES FULL AND COMPLETE RESPONSIBILITY FOR THE ACCURACY THEREIN.

City Engineer, City of Arlington

WSDOT NORTHWEST REGION

APPROVEDAREA TRAFFIC ENGINEER	DATE
engineer Wanager	DATE

ANK

 \mathbf{m} DEVELOPMENT AND SIGNAL WHIDBE TRAFFIC BRANCH





DATE 6/2/09 I SAC DRAWN DESIGNED LADD CHECKED LADD PROJECT# | 205004 SHEET TITLE


WIRING TERMINATIONS SHEET NUMBER

TS

5305

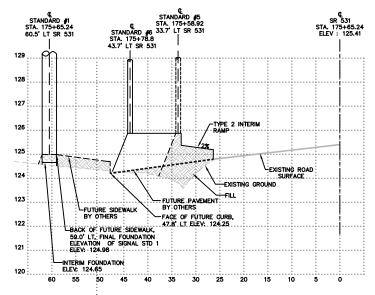

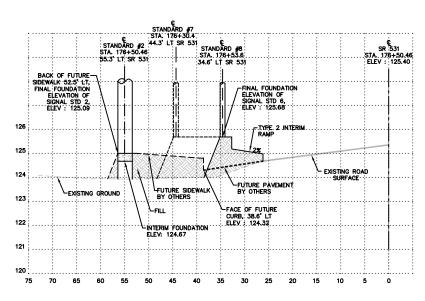


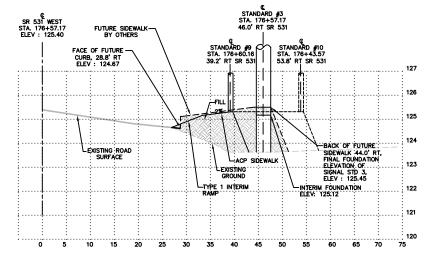


STATION: 175+65.24 ALONG SR 531

STATION: 176+50.46 ALONG SR 531

STATION: 176+57.17 ALONG SR 531

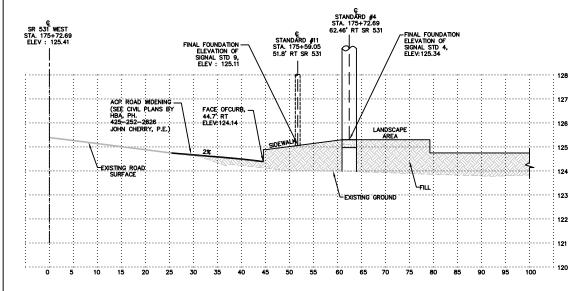

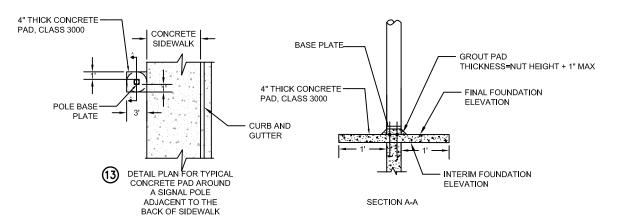

STATION: 175+72.69 ALONG SR 531

CONSTRUCTION NOTES
POLE FOUNDATIONS NEXT TO OR IN THE SIDEWALK SHALL BE PLACED FOUR INCHES (4") BELOW THE FINISHED SURFACE OF SIDEWALK. A FOUR INCH (4") CONCRETE PAD PER DETAIL DRAWING SHALL BE POURED CONCURRENTLY WITH THE SIDEWALK. THE FOUNDATION AND SIDEWALK SHALL BE SEPARATED BY A THREE QUARTER INCH (%") EXPANSION JOINT SUCH THAT THE FOUNDATION CAN BE REMOVED WITHOUT DAMAGE TO THE SURROUNDING SIDEWALK.

SCALE: 1" = 10' H 1" = 2' V

AS-BUILT DRAWING APPROVAL ACKNOWLEDGMENT

THIS AS-BUILT PLAN SHEET HAS BEEN REVIEWED AND ACCEPTED AS A RECORD DRAWING. THE LICENSED DESIGN ENGINEER WHOSE STAMP AND SIGNATURE APPEAR ON THIS SHEET ASSUMES FULL AND COMPLETE RESPONSIBILITY FOR THE ACCURACY THEREIN.

City Engineer, City of Arlington

	WSDOT	NORTHWEST	REGIO
--	-------	-----------	-------

LPPR	OVED		DATE	
REA	TRAFFIC	ENGINEER		
			DATB	
INGI	TEER MAI	LAGER		

184	PIONAL ENGINE
DATE	6/2/09

DES**I**GNED | ADD CHECKED | ADD PROJECT # 1 205004

SHEET TITLE CROSS SECTIONS

TS-1CJA ACCOUNT # 5305

DEVELOPMENT **PLANS** AND SIGNAL <u>S</u> Ш


S


ANK

 $\mathbf{\Omega}$

wh Avenue NE, Suite 100 Washington 98052-6628 4134 I www.tsinw.com

WHIDBE BRANCH [ARLINGTON, TRAFFIC

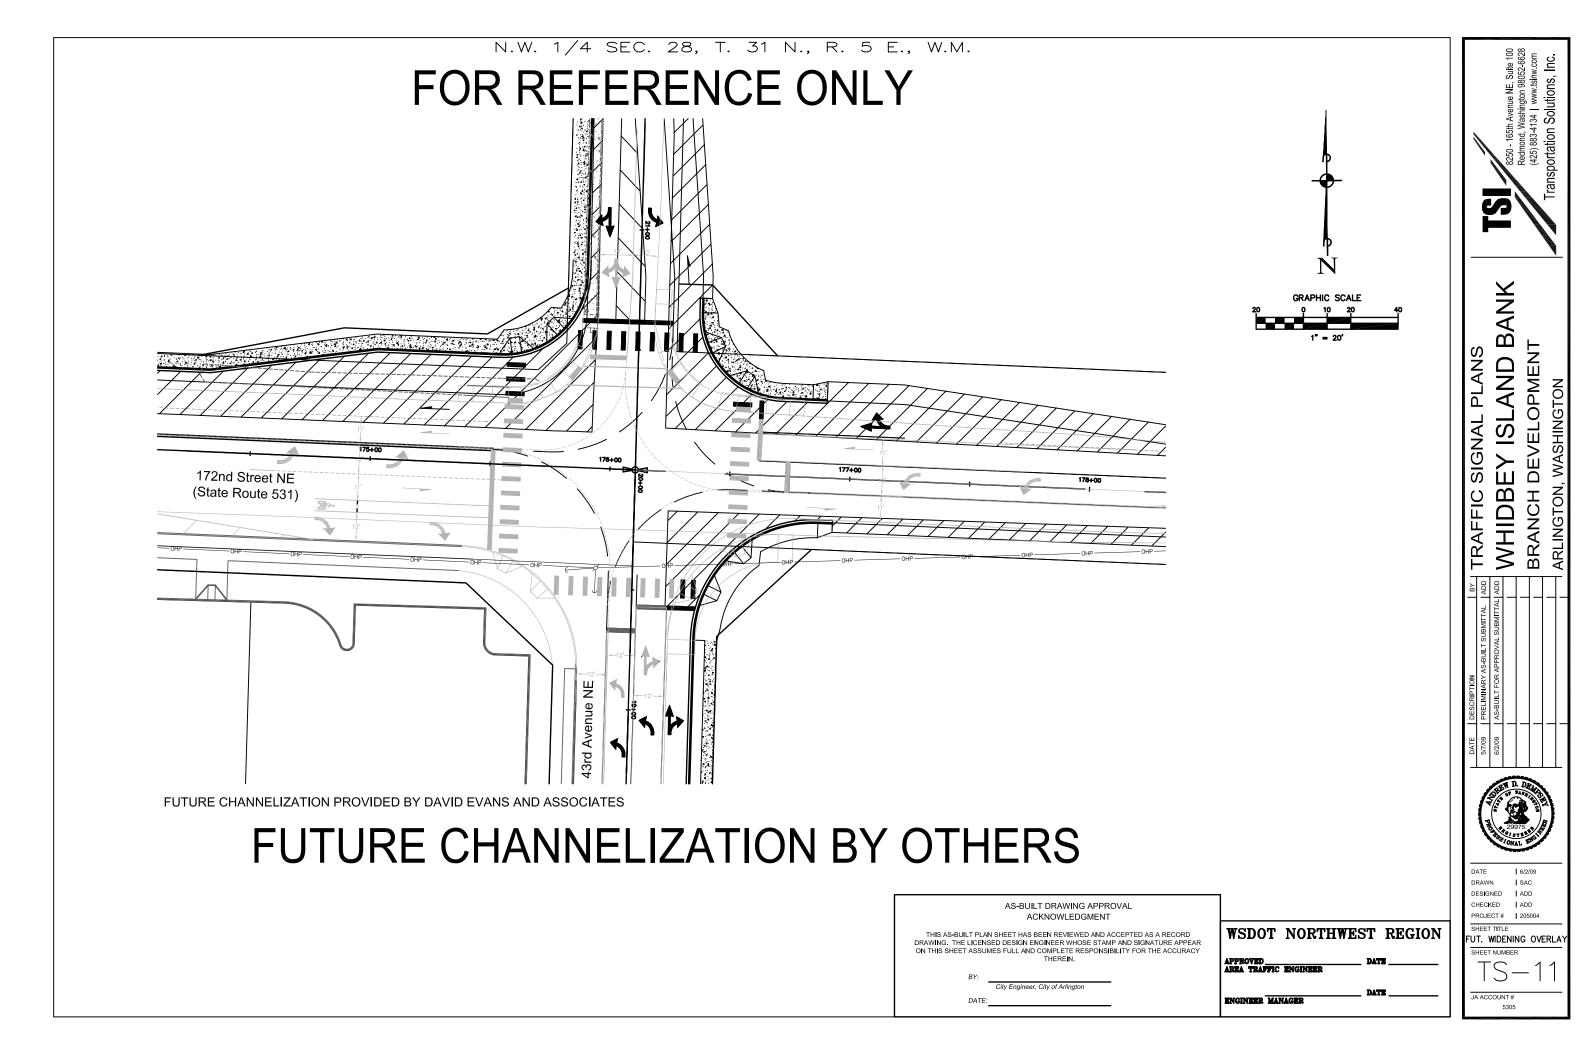

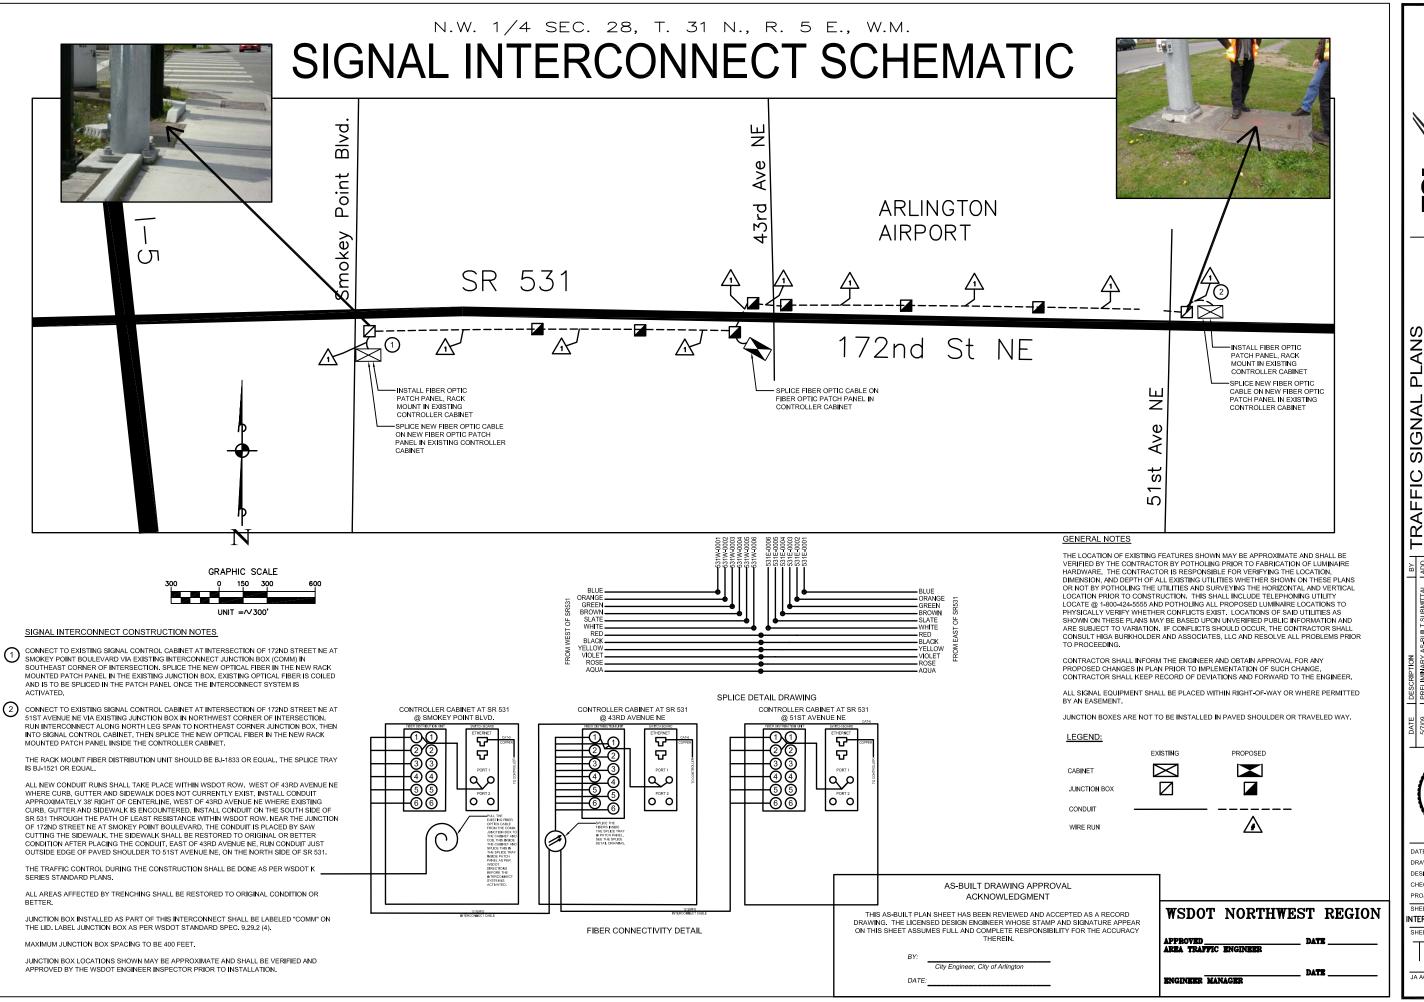



ANK M EVELOPMENT AND WHIDB BRANCH

I 6/2/09 DRAWN LSAC DESIGNED ADD CHECKED ADD PROJECT# | 205004

SHEET TITLE

INTERCONNECT SCHEMATIC SHEET NUMBER